PARTITION NOTES

NOTE: UNLESS OTHERWISE NOTED, ALL WALL FRAMING SHALL BE 20 GAUGE STUDS MINIMUM AND ALL GMB SHALL BE 5/8" TYPE X IN ALL LOCATIONS.

- 1. ALL STUDS SHALL BE "CEE" STUDS WITH FLANGE STIFFENERS
- 2. THE MATERIALS AND DETAILS SHOWN ARE FOR TYPICAL INSTALLATIONS WHERE THE STUD MANUFACTURER'S RECOMMENDATIONS
- 3. TYPICAL FASTENER:
- A. STEEL STUDS TO STEEL STUDS OR TRACKS: # 8-18 X 1/2" TEKS /2
 WITH PHIL PAN HEAD FOR 25 GA. OR 20 GA. #10 16 X 9/16" TEKS/3
 WITH PHIL PAN HEAD FOR INTERCONNECTION OF 18 GA. OR 16 GA.

OR LOCAL ORDINANCES ARE MORE RESTRICTIVE, THEY SHALL APPLY.

- B. STEEL STUDS OR TRACKS TO WOOD PURLINS, GIRDERS & BEAMS: #14-10 X 1 1/2" H.W.H. TYPE "S" METAL -TO- WOOD TEKS.
- C. STEEL STUDS OR TRACKS TO STRUCTURAL STEEL (TUBE STEEL, WIDE FLANGE COLUMNS, BEAMS, GIRDERS, ETC.): TEKS/3 OR TEKS/4 GAUGE AND LENGTH AS REQUIRED FOR THE COMBINED THICKNESS OF THE FRAMING TO BE DRILLED.
- D. PLYWOOD TO STEEL STUDS: #10 24 X 3/4" TEKS/3 (PLYMETAL TEKS) WITH THIN WAFER HEAD.
- E. GYP. BOARD TO STEEL STUDS: #7 X 1 1/4" HI-LO TYPE "S" BUGLE HEAD SCREMS FOR 3/8" TO 5/8" GYP. BOARD TO 25 GAUGE OR 20 GAUGE STUDS. #6 X 1 1/4" TYPE S-12 BUGLE HEAD SCREMS FOR 3/8" TO 5/8" TO 18 GA. OR 16 GA. STUDS OR TRACKS.


- 4. "ALIGN" MEANS SIMILAR COMPONENTS OF CONSTRUCTION, E.G., WALLS, JAMBS, ETC. SHALL ALIGN ACROSS VOIDS AND JOINTS.
- 5. PARTITIONS SHALL BE CONTINUOUS OVER DOORS SAME AS ADJACENT WALLS (UNLESS NOTED OTHERWISE) WHERE DRYWALL CONTINUES ABOVE CEILING LEVEL AND ABOVE THE CEILING LEVEL UP TO THE STRUCTURE ABOVE. ALL GYPSUM BOARD RETURNS SHALL HAVE METAL CORNER BEADS MINIMUM FLOOR TO CEILING. ALL PENETRATIONS IN DRYWALL CONSTRUCTION ABOVE FINISHED CEILING AND AS NOTED ELSEWHERE
- SHALL BE EFFECTIVELY SEALED TO PREVENT SOUND LEAKAGE AND FIRE STOP CAULKED AT U.L. RATED PARTITIONS. ALL DRY-WALL JOINTS ABOVE FINISHED CEILING SHALL BE "FIRE TAPED." ALL MECHANICAL CHASES AND OTHER NOTED CHASES ARE TO EXTEND UP TO THE UNDERSIDE OF THE DECK STRUCTURE ABOVE. ALL PLUMBING CHASES UNLESS OTHERWISE NOTED SHALL EXTEND ABOVE THE HIGHEST ADJOINING CEILING AND BE BRACED TO STRUCTURE. ALL VERTICAL DIMENSIONS SHOWN ARE TO THE TOP OF THE SLAB, UNLESS NOTED OTHERWISE.
- 6. DRYWALL CONTROL JOINTS ARE TO BE INSTALLED AT MINIMUM 30'-0" O.C. AT PARTITIONS AND ELSEWHERE AS NOTED. COORDINATE LOCATIONS W/ THE ARCHITECT.
- 7. ALL CONSTRUCTION DESIGNATED TO BE SUPPORTED BY ROOF STRUCTURE SHALL BE SUPPORTED BY TOP CHORD OF STRUCTURAL JOISTS AND NOT FROM THE METAL DECK.


- 8. ALL TENANT FRAMING SHALL BE METAL STUDS.
- 9. ALL WOOD REFERRED TO IN SPECIFICATIONS, INCLUDING PLYWOOD AND WOOD BLOCKING IS TO BE FIRE RETARDANT TREATED.
- 10. INSTALL 5/8" REINFORCED CEMENT UNDERLAYMENT BOARD BEHIND ALL TILE ON WALLS REFER PLANS FOR LOCATIONS.
- 11. RUNNERS TO BE SET IN BED OF ACOUSTIC SEALANT AT ALL AREAS. CONTINUOUS BEAD UNDER RUNNER, AND SEAL EACH SIDE AT WALL/FLOOR.
- 12. CONTRACTOR TO PROVIDE SOLID, CONTINUOUS, FIRE RATED WOOD BLOCKING FOR ALL MILLWORK, ACCESSORIES AND OTHER MISCELLANEOUS ASSEMBLIES REQUIRING BLOCKING


SIZE	GA.	TYPE	16" O.C.		24" O.C.
			MAX. UNSUPPORTED HEIGHT		NOTE 1, 2, 3
2 1/2"	25	ST	UP TO	12'-6"	10'-9"
	22	ST	11 11	13'-0"	11'-6"
	20	ST	11 11	13'-10"	12'-0"
3 5/8"	25	ST	UP TO	16'-0"	13'-6"
	22	ST	11 11	17'-3"	15'-0"
	20	ST	11 11	17'-11"	15'-7"
	20	SJ	11 11	18'-6"	16'-9"
	18	SJ	11 11	19'-3"	
	16	SJ	11 11	20'-0"	
	14	SJ	11 11	22'-0"	
6"	22	ST	UP TO	25'-3"	22'-0"
	20	ST	11 11	26'-1"	22'-10"
	20	SJ	11 11	26'-8"	23'-8"
	18	SJ	11 11	28'-0"	
	16	SJ	11 11	30'-0"	
	14	SJ	11 11	32'-0"	

METAL STUD SCHEDULE

- BASED ON INTERIOR NON-BEARING PARTITIONS WITH (1) LAYER OF GYP. BD.
 EA. SIDE. USE GAUGE, TYPE AS SCHEDULED UNLESS NOTED OTHERWISE ON DWGS.
- 2. RUNNER TRACK GAUGE TO MATCH STUD.
- 3. MOISTURE RESISTANT GWB TO BE USED IN JANITORS CLOSET AND RESTROOMS.

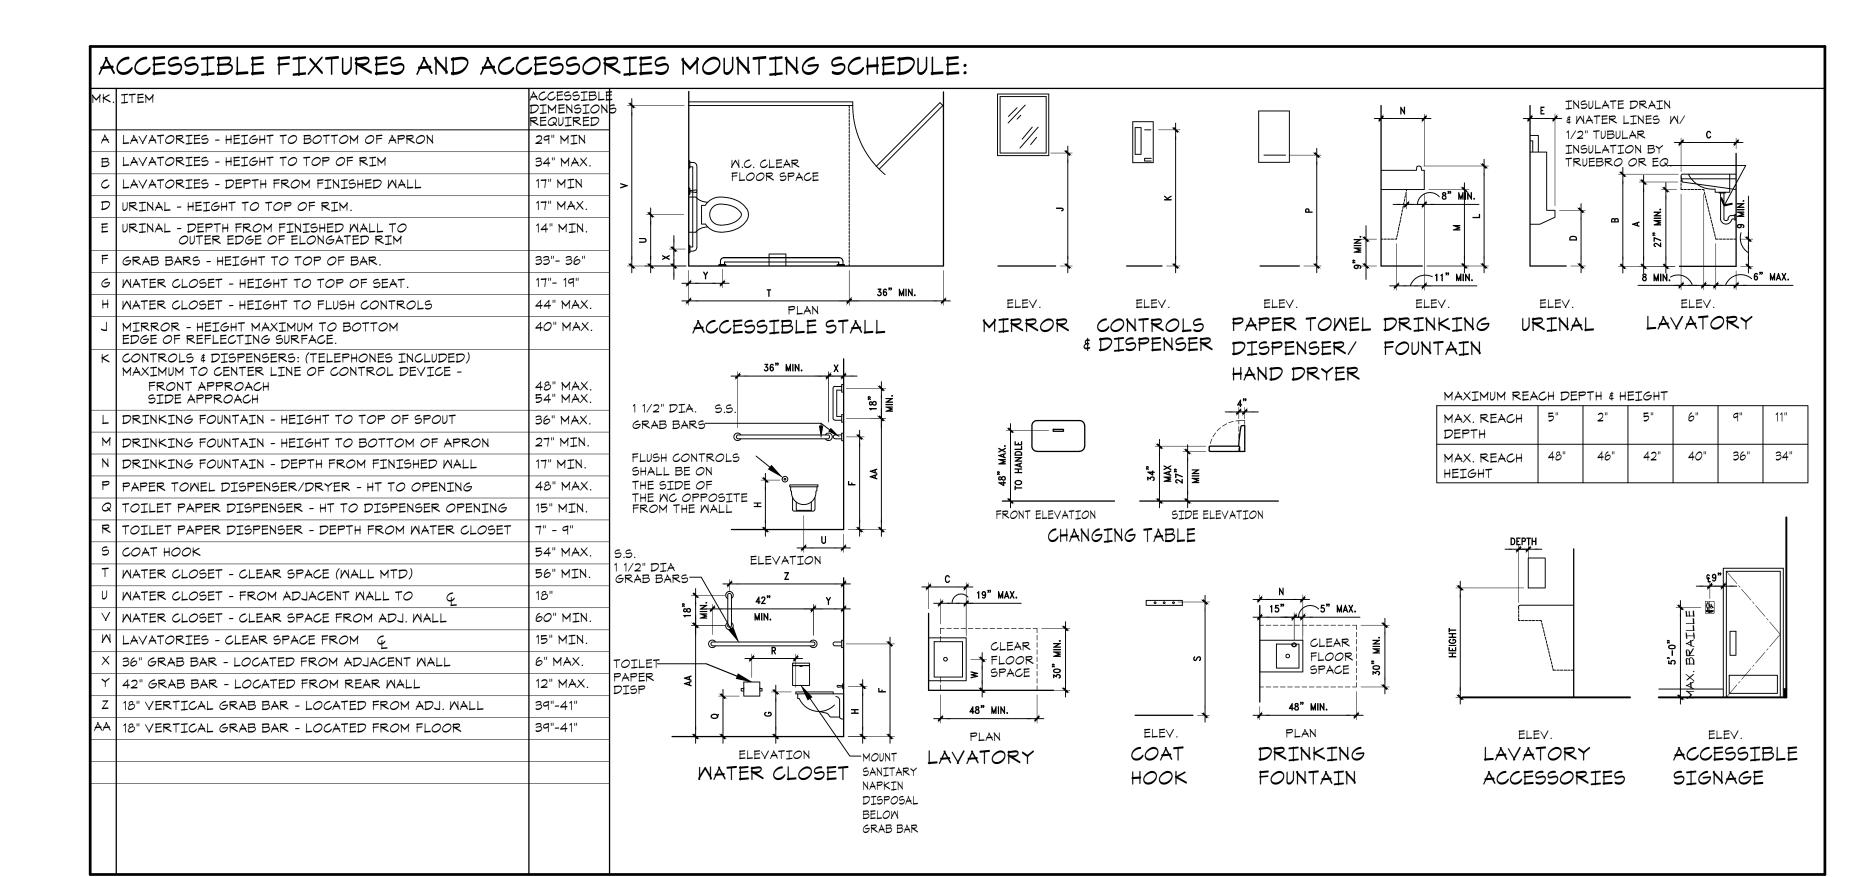

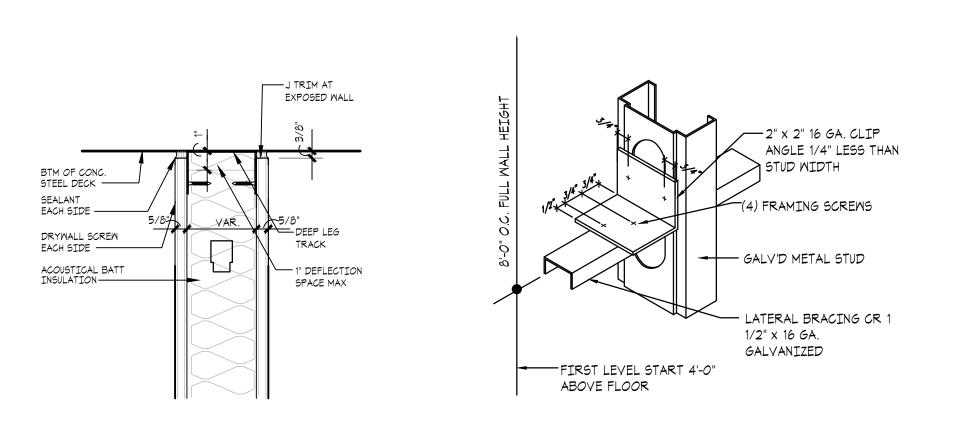

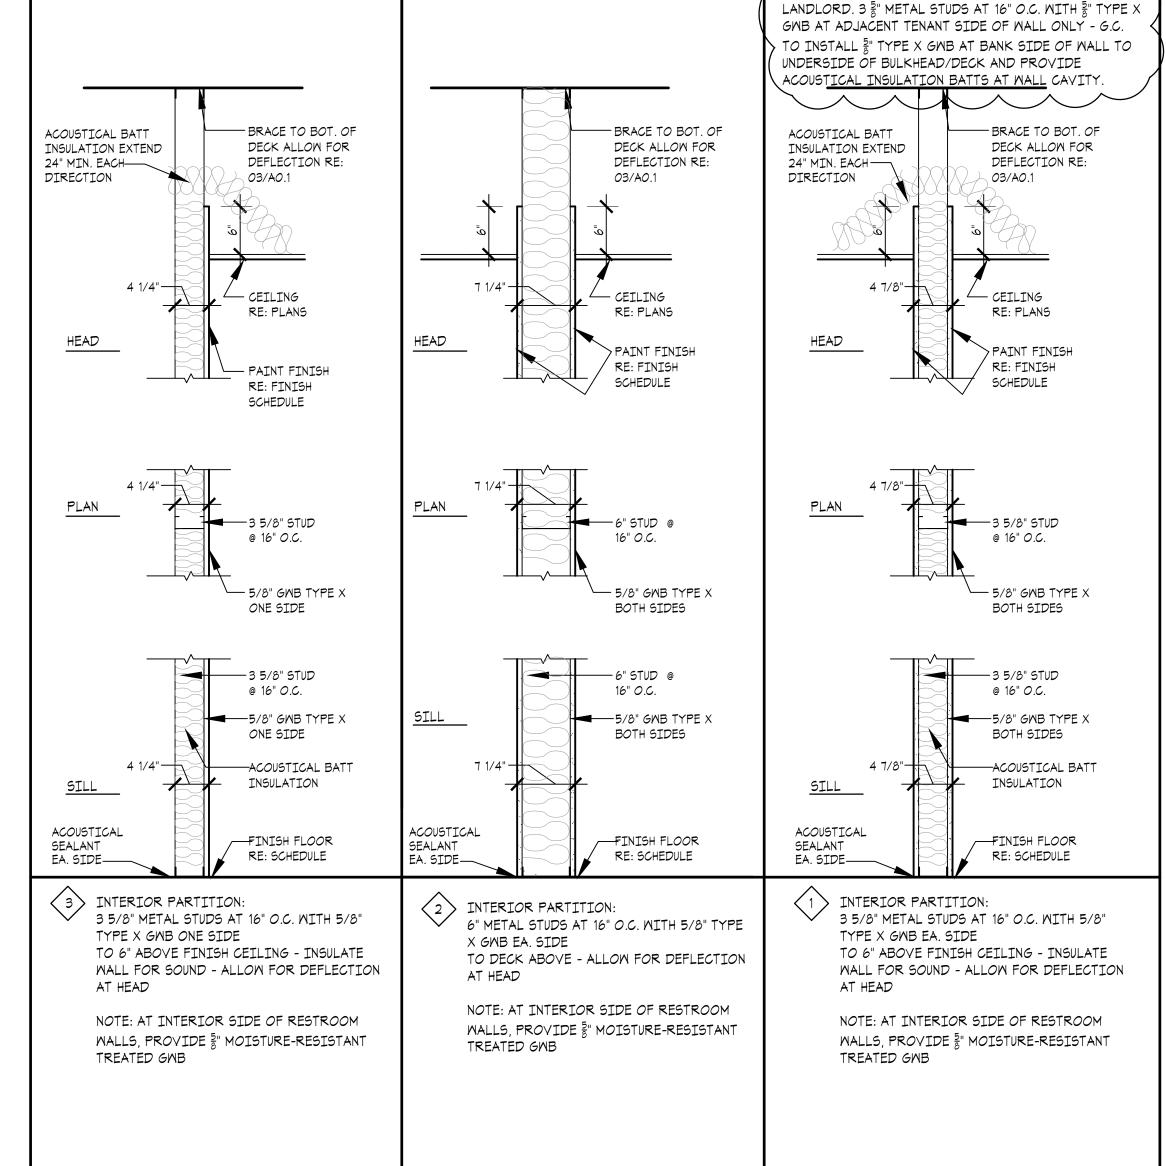

THE MCKINNEY PARTNERSHIP architects

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NOTE: NEW DEMISING WALL CONSTRUCTED BY

PARTITION TYPES

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PARTITION TYPES, TYPICAL DETAILS, FIXTURE MOUNTING SCHEDULE

Sheet Number:

A0.1

O3 NON-RATED PARTITION HEAD SCALE: N.T.S.

02 LATERAL BRACING DETAIL
SCALE: N.T.5.

GENERAL DEMOLITION NOTES

- 1. THE SCOPE OF THE WORK INCLUDES ALL INTERIOR ELEMENTS NECESSARY TO ACCOMMODATE THE NEW WORK. THIS INCLUDES, BUT IT NOT LIMITED TO, ALL INDICATED NON-LOAD BEARING INTERIOR WALLS, DOORS, CEILINGS AND FLOOR FINISHES DOWN TO A CLEAN AND LEVEL WORKING SURFACE. ALL EXISTING CONSTRUCTION TO REMAIN U.N.O.
- 2. THE DEMO CONTRACTOR SHALL VERIFY ALL FIELD CONDITIONS AND NOTIFY GENERAL CONTRACTOR OF ANY DISCREPANCIES PRIOR TO COMMENCEMENT OF THE WORK.
- 3. DURING THE DEMOLITION PHASE THE DEMO CONTRACTOR SHALL SUPPORT ALL EXISTING STRUCTURES AS REQUIRED TO MAINTAIN A SAFE WORKING ENVIRONMENT. ANY DAMAGE CAUSED BY THE DEMOLITION PROCESS WILL BE CORRECTED BY THE DEMO CONTRACTOR AT NO COST TO TENANT.
- 4. IF THE DEMOLITION PROCESS RESULTS IN AN UNSAFE WORKING ENVIRONMENT, STOP WORK IMMEDIATELY AND NOTIFY THE APPROPRIATE AUTHORITY, GENERAL CONTRACTOR AND ARCHITECT PRIOR TO PROCEEDING.
- 5. PROVIDE ALL LIFE SAFETY SYSTEMS INCLUDING, BUT NOT LIMITED TO, TEMPORARY LIGHTING BARRICADES, GUARD RAILS AND VENTILATION SYSTEMS AS REQUIRED BY LOCAL, STATE AND FEDERAL JURISDICTIONS.
- 6. DEMO CONTRACTOR SHALL ARRANGE TO IMMEDIATELY REMOVE AND LEGALLY DISPOSE OF ALL DEMOLITION MATERIALS.
- 7. PROCEED WITH DEMOLITION IN ACCORDANCE WITH ALL APPLICABLE CODES AND REGULATIONS.
- 8. COORDINATE WITH LANDLORD ON RUBBISH REMOVAL PROCEDURES, LOCATION OF TRASH DUMPSTERS TIME SCHEDULES, ETC. DISPOSE OF ALL RUBBISH IN A MANNER COMPLIANT WITH ALL LAWS, REGULATIONS, ETC.
- 9. PRIOR TO THE START OF ANY NEW CONSTRUCTION, CLEAN THE SITE OF ALL DEMOLITION DEBRIS. DEMO CONTRACTOR SHALL ASSURE THAT THE DEMOLITION WORK IS COMPLETE TO THE POINT WHERE NO ADDITIONAL DEMOLITION SHALL BE REQUIRED.
- 10. CONSULT WITH GENERAL CONTRACTOR PRIOR TO THE START OF DEMOLITION TO DETERMINE THE SCOPE OF ALL MATERIALS, FINISHES AND SYSTEMS THAT ARE TO BE
- 11. ALL UTILITIES TO REMAIN U.N.O.
- 12. COORDINATE WITH LANDLORD ON DEMOLITION TIME RESTRICTIONS.
- 13. REFER MECHANICAL, ELECTRICAL, AND PLUMBING DRAWINGS FOR ADDITIONAL DEMOLITION ITEMS.


DEMOLITION KEY NOTES:

- 1 EXISTING FLOORING MATERIAL TO BE REMOVED THROUGHOUT.
- 2 REMOVE PORTION OF EXISTING WALL.
- 3 REMOVE EXISTING BULKHEAD FRAMING, FINISH AND INSULATION.
- REMOVE CEILING GRID, TILE, HVAC COMPONENTS, SPEAKERS, LIGHT FIXTURES, INSULATION, ETC.
- TEMPORARILY BRACE & PROTECT EXISTING FURRDOWN ABOVE TO REMAIN. REFER TO REFLECTED CEILING PLAN.
- 6 PRESERVE AND PROTECT EXISTING MILLWORK TO BE REFURBISHED.
- 7 REMOVE EXIT SIGN.
- 8 REMOVE SAFE DEPOSIT BOXES AND RETURN TO OWNER.
- q > REMOVE COFFEE BAR MILLWORK AND CAP WATER SUPPLY LINE.
- REMOVE CONCRETE PAVING FROM EXISTING PANELS IN SIDEWALK FOR NEW PLANTING AREAS.
- 11 REMOVE MASONRY WALLS AND ALUMINUM/GLASS DOORS.
- 12 REMOVE METAL COLUMN COVER.
- (13) REMOVE SECTION OF ALUMINUM STOREFRONT GLASS AND ENTRY DOORS.
- 14 REMOVE SUSPENDED FLUORESCENT AND TRACK LIGHT FIXTURES.
- REMOVE EXISTING CEILING TILE. CEILING GRID AND LIGHT FIXTURES TO REMAIN.
- REMOVE TILE AND LIGHT FIXTURES ONLY AT THIS CEILING AREA. GRID, DIFFUSERS, ETC. TO REMAIN.
- REMOVE ALUMINUM GATE AND RETURN TO OWNER.
- REMOVE EXISTING HVAC DUCTWORK, PLENUM AND CEILING MOUNTED DIFFUSERS.
- REMOVE CONCRETE FLOOR SLAB AS REQUIRED FOR CONNECTION OF NEW PLUMBING FIXTURES TO LANDLORD'S SANITARY SEWER LINE.
- 20 REMOVE WALL, DOOR AND TRIM.
- REMOVE DAMAGED CONCRETE PANELS IN SIDEWALK TO BE REPLACED WITH NEW (6 TOTAL).

WALL LEGEND

EXISTING WALL CONSTRUCTION TO REMAIN

EXISTING CONSTRUCTION TO BE DEMOLISHED

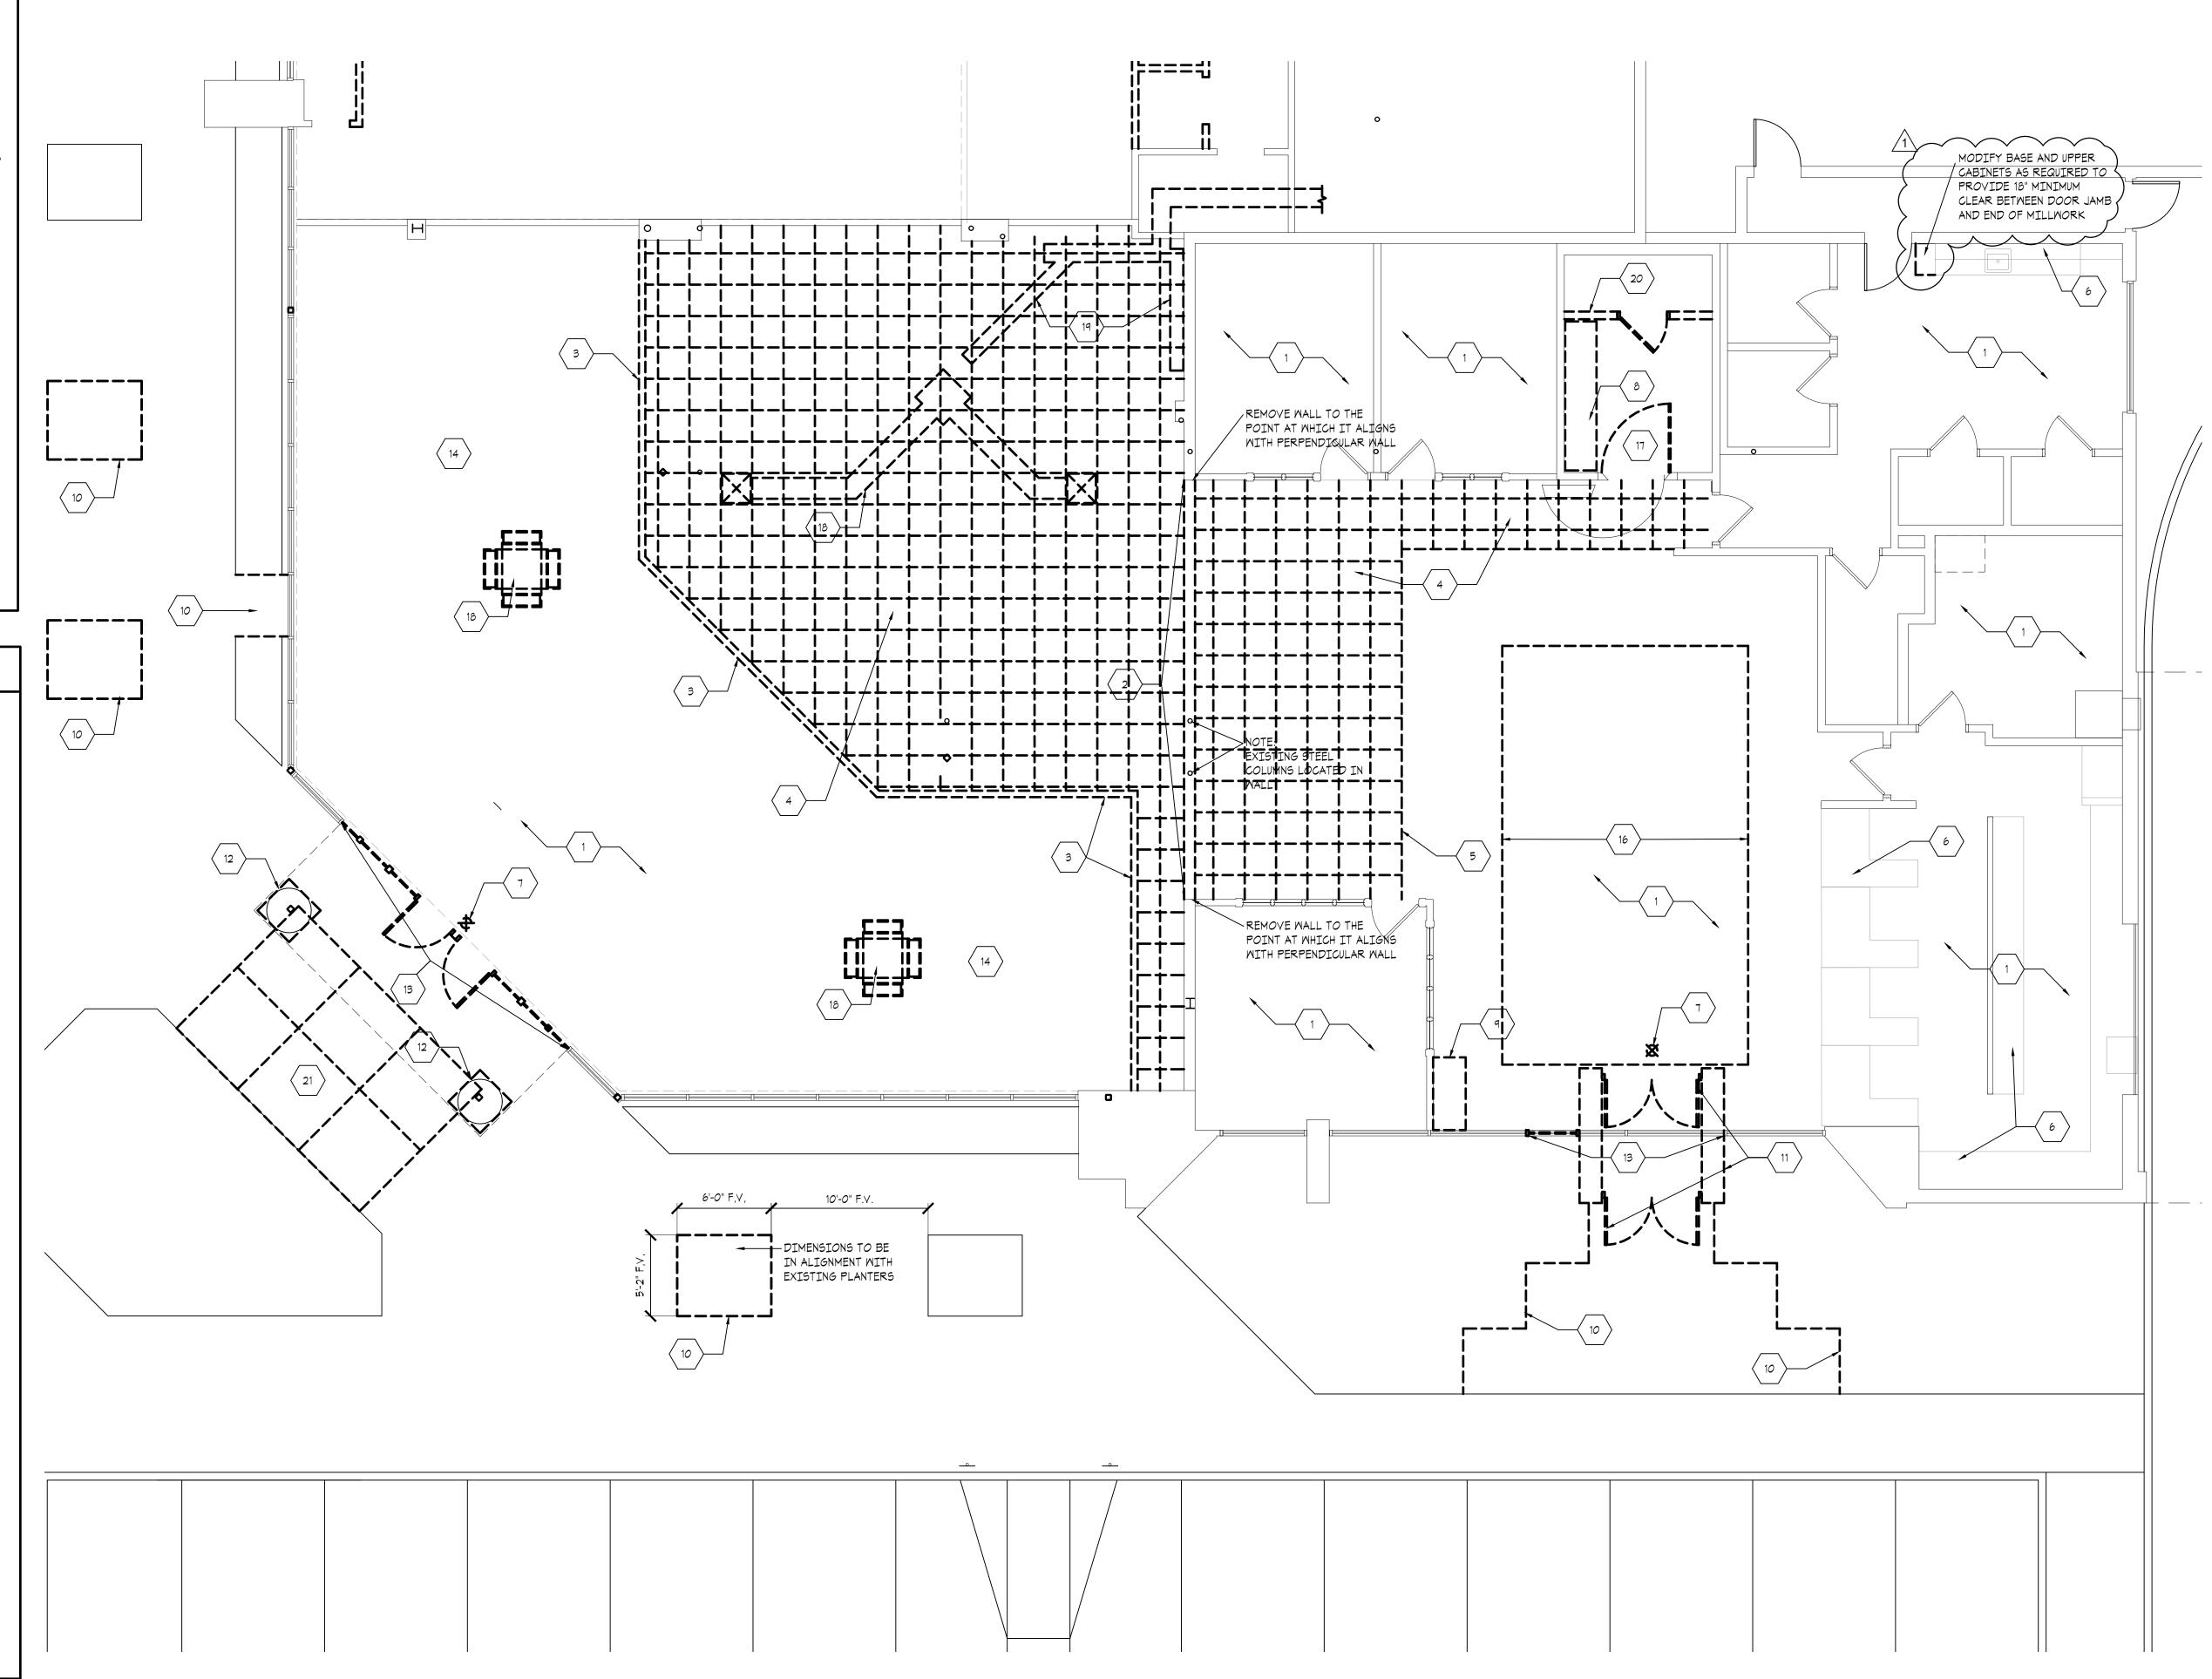



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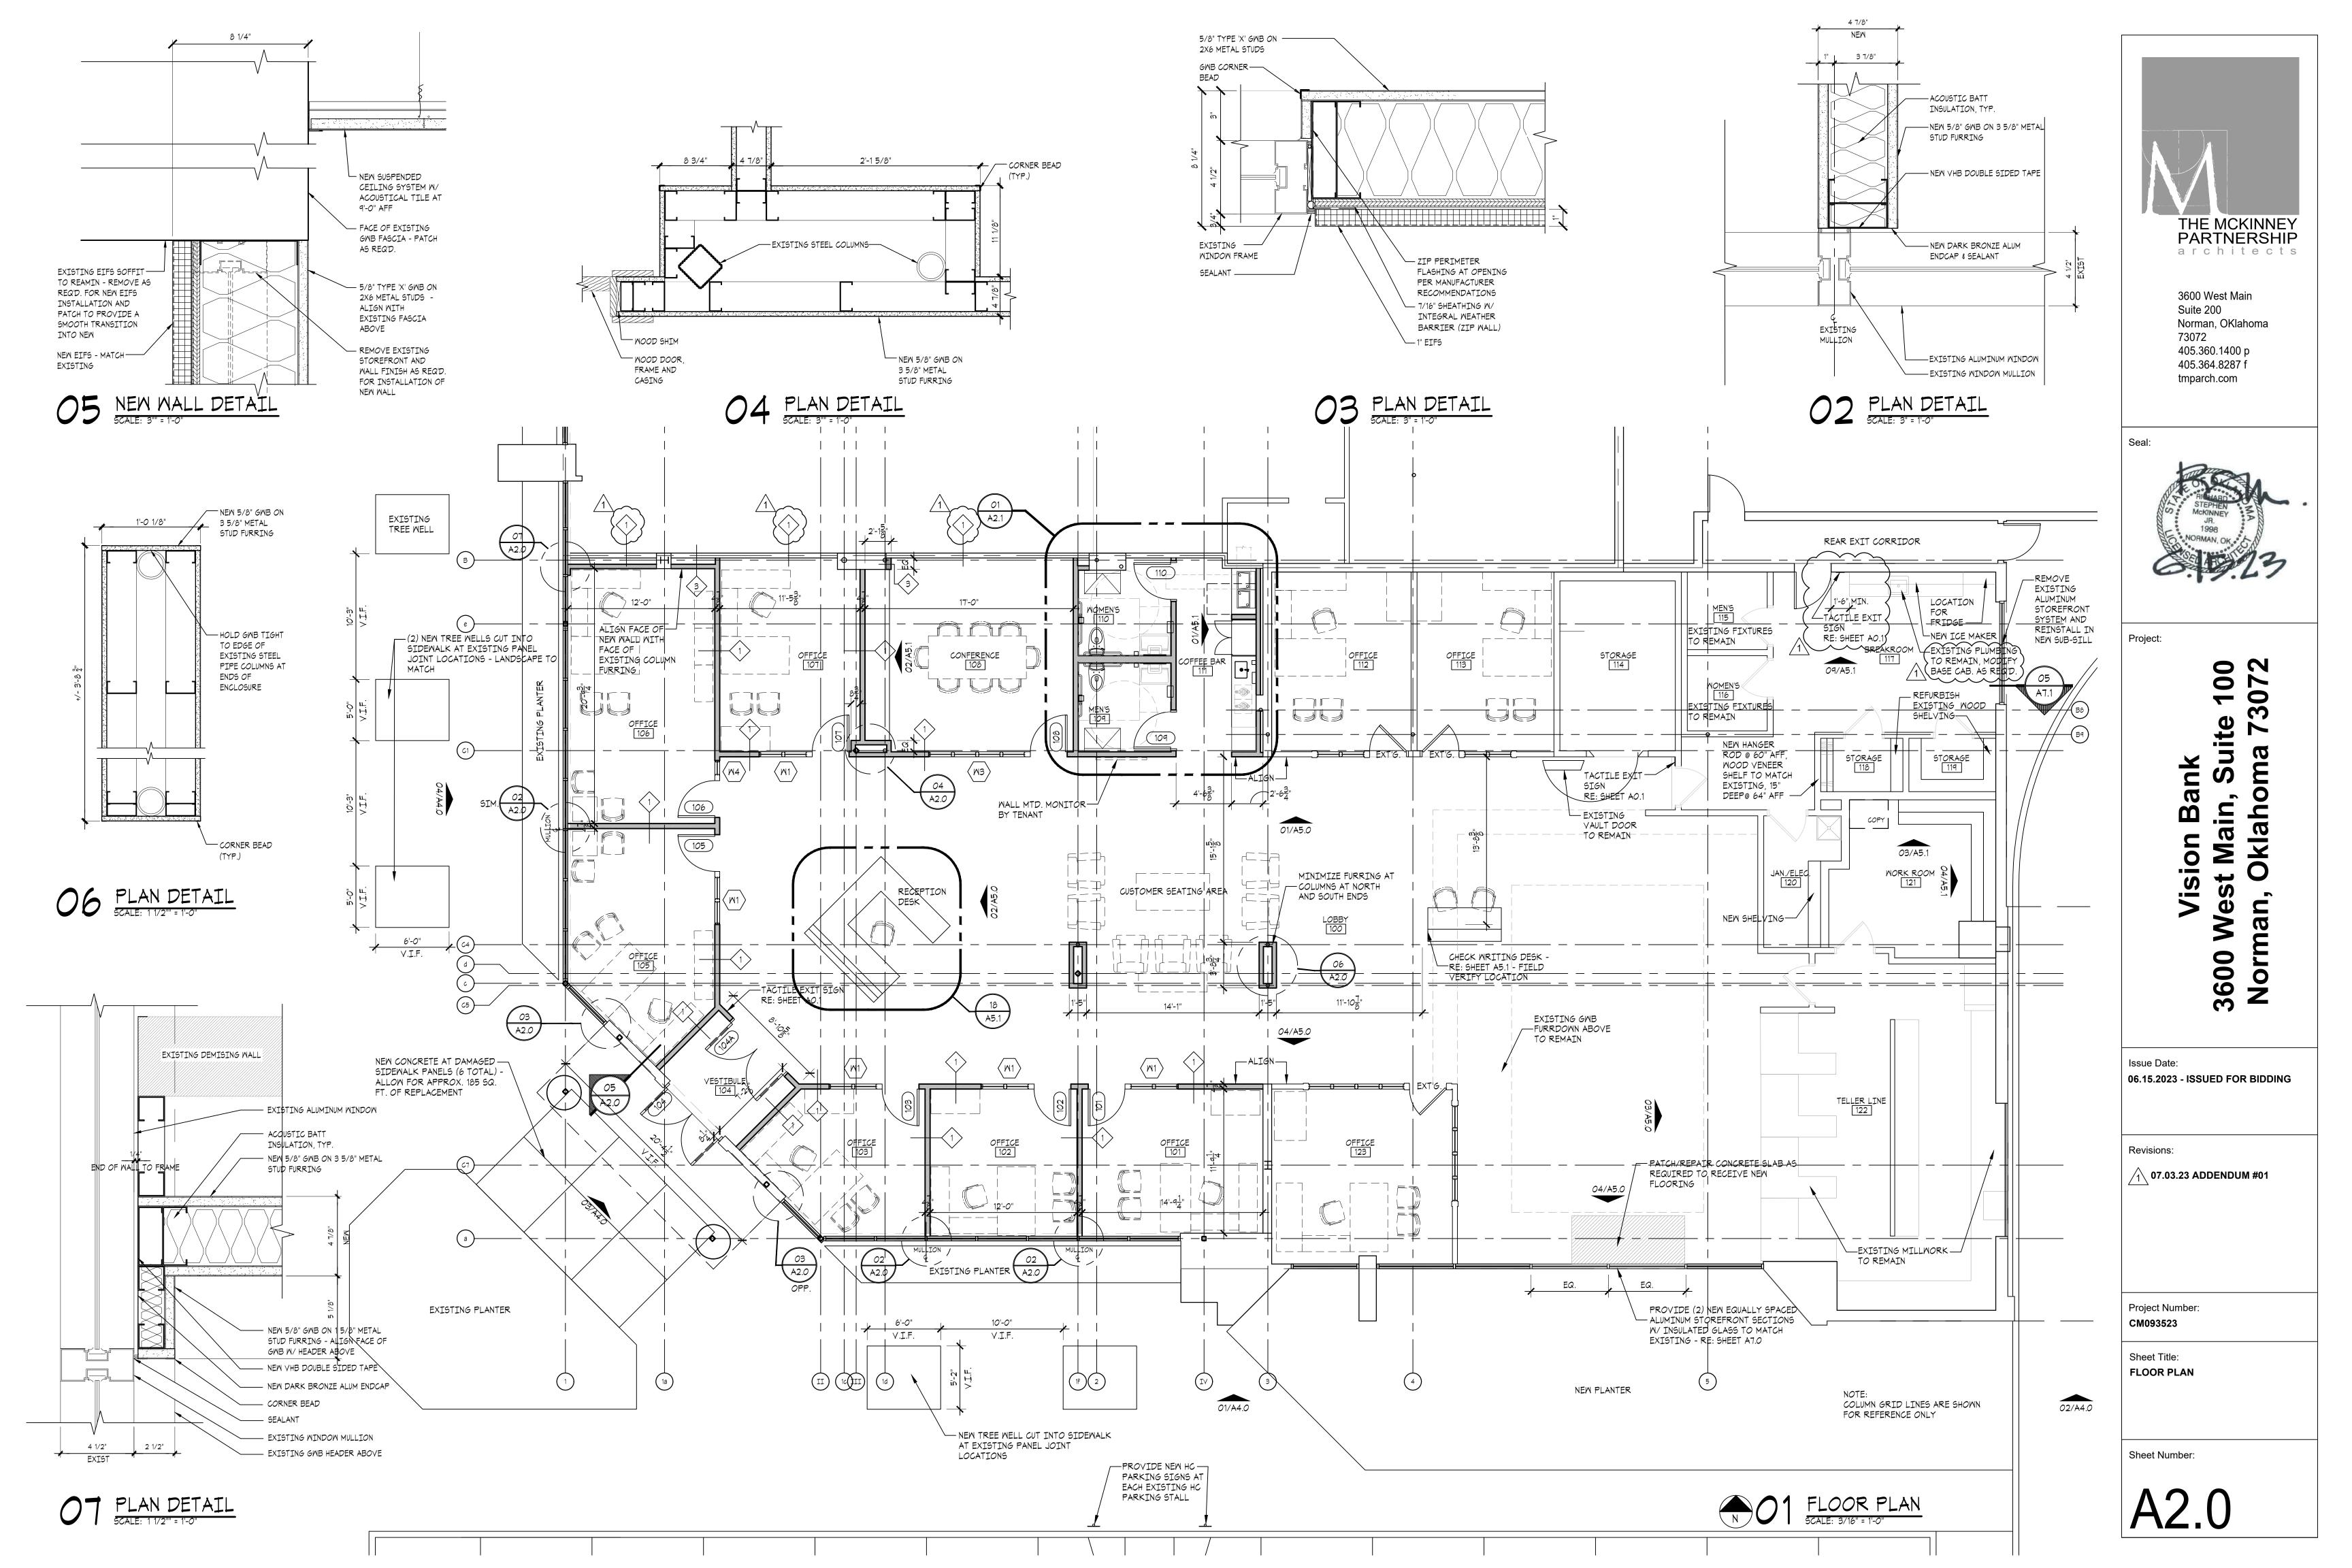
Project Number: CM093523

Sheet Title: **DEMOLITION PLAN**

Sheet Number:

DEMOLITION PLAN
SCALE: 3/16" = 1'-0"

D1.0



TOILET NOTES: TOILET ACCESSORIES: MARK | DESCRIPTION REFER TO SHEET P1.0 FOR PLUMBING FIXTURE LEGEND. WOOD FRAMED MIRROR 2. REFER TO ACCESSIBLE FIXTURES AND ACCESSORIES MOUNTING SCHEDULE ON SOAP DISPENSER SHEET A2.1. 3. ALL CONSTRUCTION AND MOUNTING 36" GRAB BARS AT 36" AFF HEIGHTS SHALL COMPLY WITH ALL APPLICABLE CITY AND STATE 42" GRAB BARS AT 36" AFF ACCESSIBILITY REGULATIONS AS WELL 18" VERTICAL GRAB BARS AT 40" AFF AS THE FEDERAL ADA (AMERICANS WITH DISABILITY ACT) REGULATIONS. REFER TOILET PAPER DISPENSER QUESTIONABLE MOUNTING HEIGHTS TO THE ARCHITECT FOR FINAL DECISION. REFER SCHEDULE THIS SHEET COAT HOOK PAPER TOWEL DISPENSER / TRASH CAN 4. PROVIDE SOLID CONTINUOUS F.R. (RECESSED) MOOD BLOCKING IN WALLS AS REQUIRED FOR ATTACHING PAPER TOWEL DISPENSER / TRASH CAN

(WALL MOUNT, RECESSED)

BABY CHANGING STATION


NOT USED NOT USED

ACCESSIBLE TOILET SIGNAGE

ACCESSORIES, RAILS AND EQUIPMENT.

5. TRASH RECEPTACLES PROVIDED BY

OWNER.

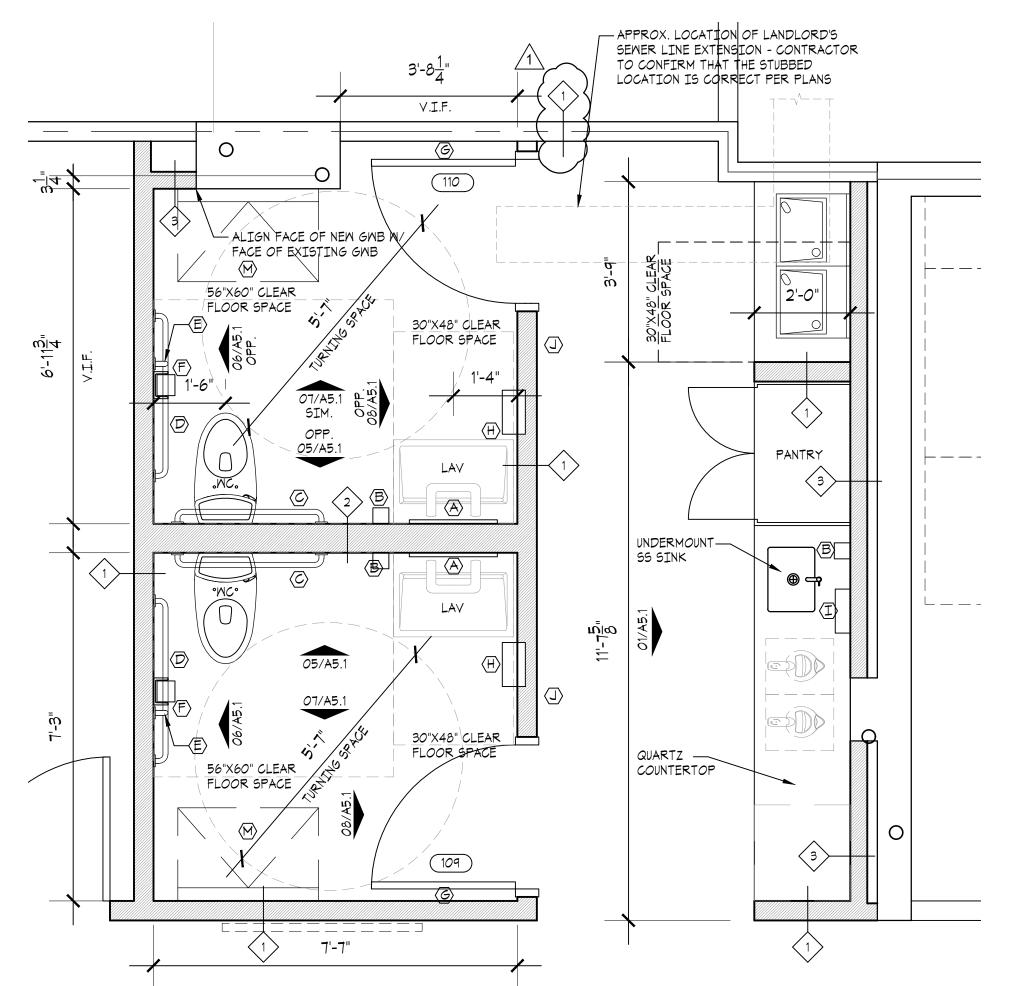

MANUF./MODEL NO.

BOBRICK, B-5806 X 36

BOBRICK, B-5806 X 42

BOBRICK, B-5806 X 18

DISPENSER/WASTE RECEPTACLE

COMPLY W/ 2010 ADA STANDARDS

KOALA KARE, MODEL#KB200, GREY

BOBRICK B-4288 S

BOBRICK, B-682

MOOD AND VENEERS, CLARET SUEDE

KOHLER DAMASK FRAMED MIRROR, GLASS AND SOLID

BOBRICK B-3940 RECESSED CONVERTIBLE PAPER TOWEL

BOBRICK B-262, CLASSIC SERIES, SURFACE MOUNT, 22 GA.

STAINLESS STEEL, SATIN FINISH, HEMMED OPENING

BOBRICK B2012, AUTOMATIC WALL MOUNTED SOAP



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ENLARGED PLANS

Sheet Number:

